
# BEDE POLDING COLLEGE - ALTERATIONS AND ADDITIONS 20-22 RIFLE ROAD SOUTH WINDSOR NSW 2756 CIVIL STORMWATER DRAINAGE AND EXTERNAL WORKS PLAN

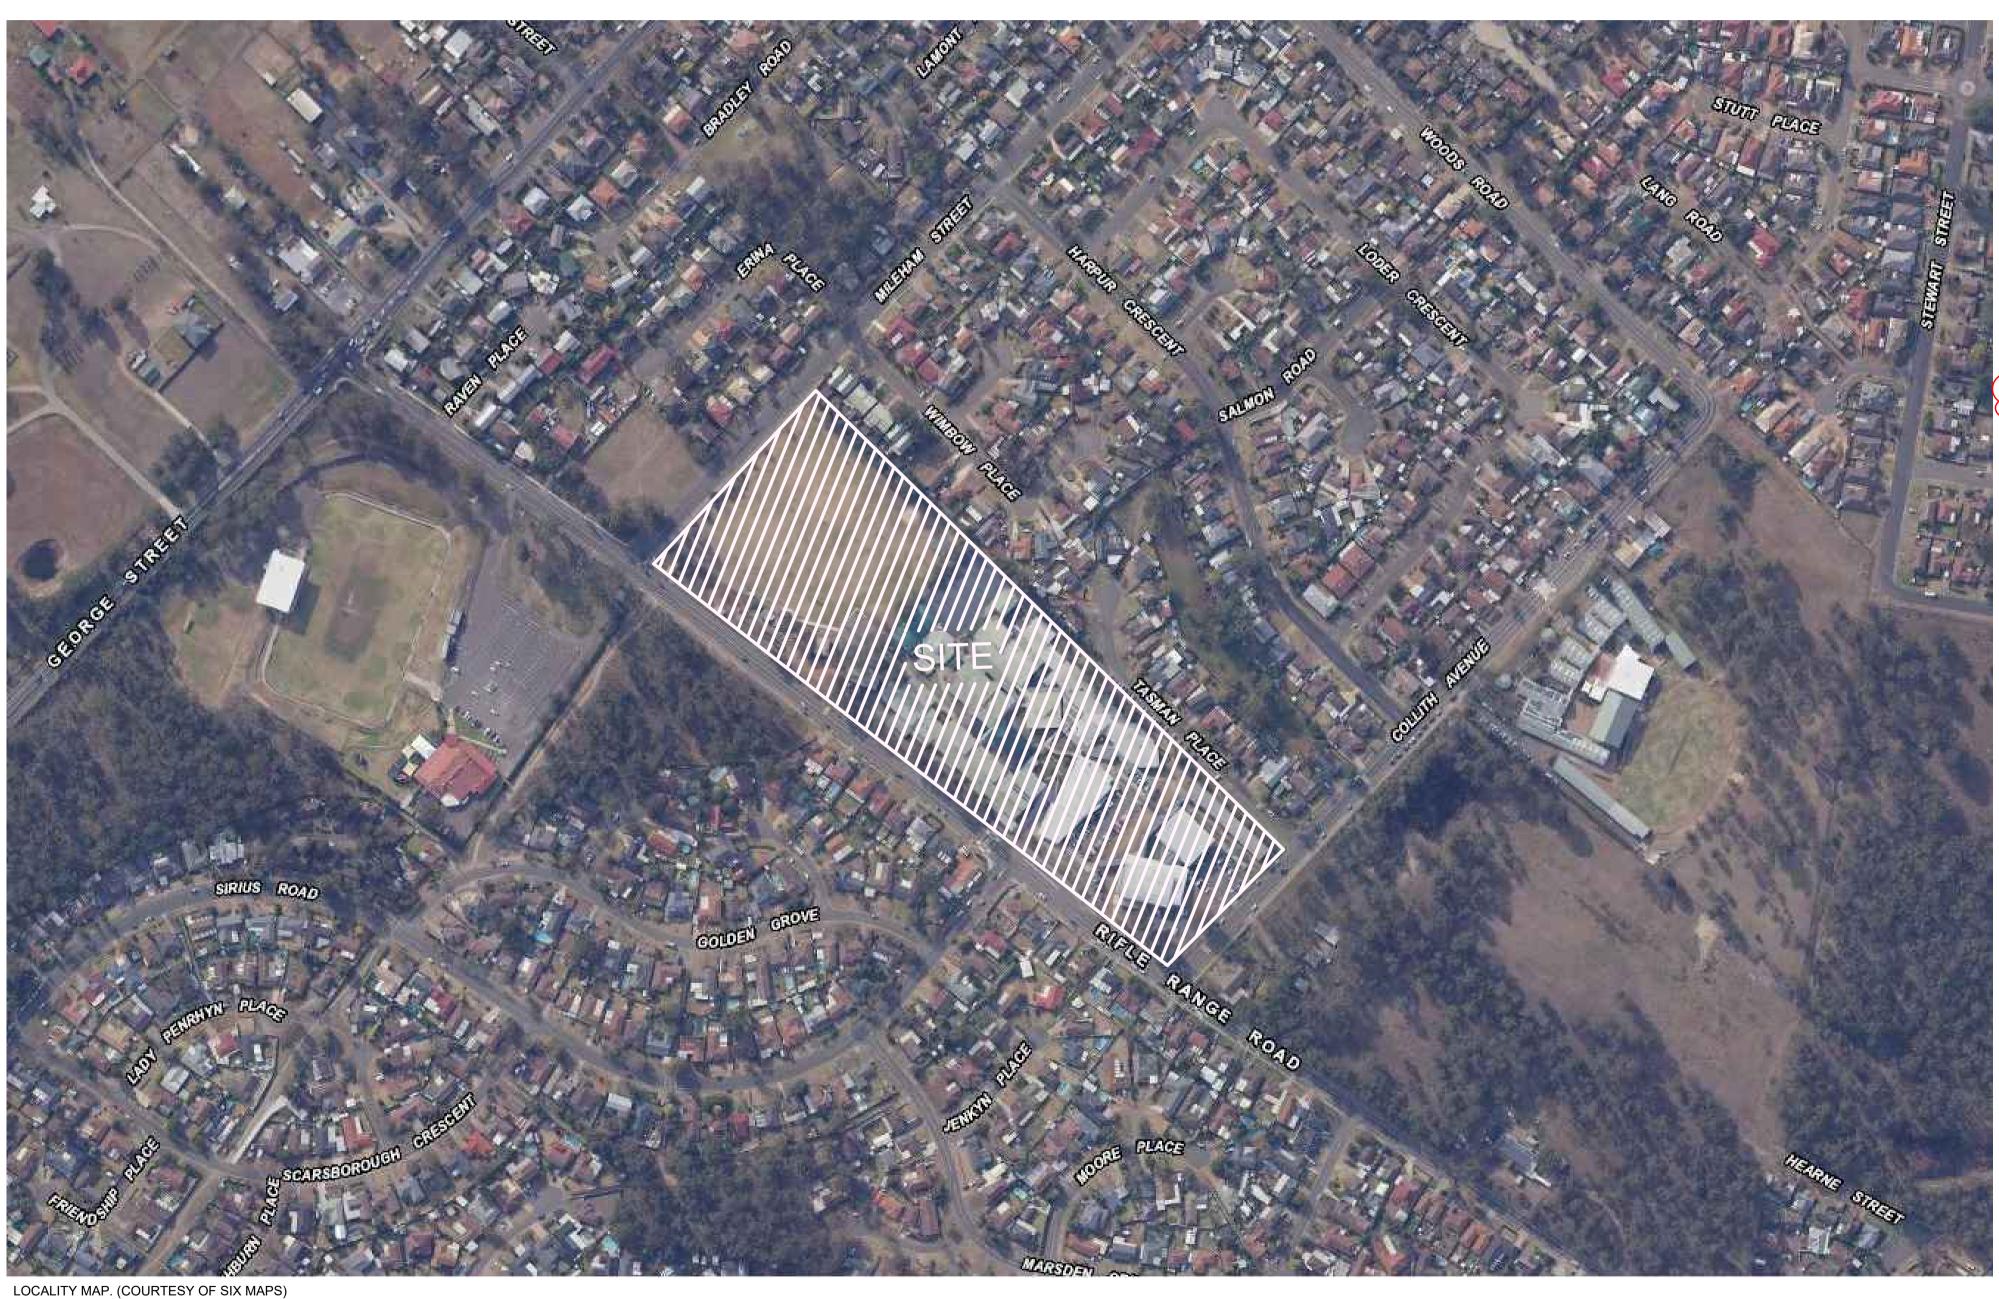

	NO.	TITLE	NO.	TITLE
	C.DA.01	COVER SHEET	C.DA.12	CIVIL WORKS PLAN - SHEET 2
	C.DA.02	CONSTRUCTION NOTES - SHEET 1	C.DA.13	CIVIL WORKS PLAN - SHEET 3
	C.DA.03	CONSTRUCTION NOTES - SHEET 2	C.DA.14	DETAILS SHEET 1 - STORMWATER
	C.DA.04	SOIL EROSION & SEDIMENT CONTROL PLAN - SHEET 1	C.DA.15	DETAILS SHEET 2 - STORMWATER
	C.DA.04A	SOIL EROSION & SEDIMENT CONTROL PLAN - SHEET 1A	C.DA.16	DETAILS SHEET 3 - CIVIL
	C.DA.05	SOIL EROSION & SEDIMENT CONTROL PLAN - SHEET 2	C.DA.17	DETAILS SHEET 4 - CIVIL
	C.DA.06	SOIL EROSION & SEDIMENT CONTROL DETAILS	C.DA.18	DETAILS SHEET 5 - CIVIL
	C.DA.07	CUT AND FILL PLAN	C.DA.30	CATCHMENT PLAN - SHEET 1
	C.DA.08	BULK SECTIONS - SHEET 1	C.DA.31	CATCHMENT PLAN - SHEET 2
(	C.DA.08A	BULK SECTIONS - SHEET 1A	C.DA.32	CATCHMENT PLAN - SHEET 3
	C.DA.09	BULK SECTIONS - SHEET 2	C.DA.40	MUSIC MODEL
	C.DA.10	CIVIL WORKS OVERALL PLAN	C.DA.50	EXISTING FLOOD STUDY PLAN
	C.DA.11	CIVIL WORKS PLAN - SHEET 1	C.DA.51	DESIGN FLOOD STUDY PLAN
	C.DA.11A	CIVIL WORKS PLAN - SHEET 1A		





SOIL EROSION AND SEDIMENT CONTROL PLAN - SHEET 1A

# GENERAL NOTES.

. THIS PLAN IS A CONCEPT PLAN ONLY FOR CONSTRUCTION SEDIMENT & EROSION CONTROL. IT IS NOT SUITABLE FOR CONSTRUCTION. THIS PLAN SHOULD BE ADAPTED BY THE BUILDER DURING DEMOLITION, EXCAVATION & CONSTRUCTION PHASES TO ENSURE ADEQUATE PERFORMANCE.

2. ALL DRAINAGE LAYOUT & DETAILS ARE DIAGRAMMATIC & INDICATIVE ONLY. ACTUAL LOCATION, SIZES, LEVELS & GRADES MAY LATER WHEN DETAIL DESIGN WORKS ARE DOCUMENTED.

# **EROSION & SEDIMENTATION** CONTROL NOTES

1. CONTRACTOR SHALL PROVIDE SEDIMENT FENCING MATERIAL DURING CONSTRUCTION TO THE LOW SIDE OF THE WORKS. TIE SEDIMENT FENCING MATERIAL TO CYCLONE WIRE SECURITY FENCE. SEDIMENT CONTROL FABRIC SHALL BE AN APPROVED MATERIAL (EG. HUMES PROPEX SILT STOP) STANDING 300mm ABOVE GROUND & EXTENDING 150mm BELOW GROUND.

2. EXISTING DRAINS LOCATED WITHIN THE SITE SHALL ALSO BE ISOLATED BY SEDIMENT FENCING MATERIAL.

3. NO PARKING OR STOCKPILING OF MATERIAL IS PERMITTED ON THE LOWER SIDE OF THE SEDIMENT FENCE.


PROVIDE A BUFFER ZONE TO THE CONSTRUCTION SITE. 5. CONSTRUCTION ENTRY/EXIT SHALL BE VIA THE LOCATION NOTED ON THE DRAWING. CONTRACTOR SHALL ENSURE ALL DROPPABLE SOIL & SEDIMENT IS REMOVED PRIOR TO CONSTRUCTION TRAFFIC EXITING SITE. CONTRACTOR SHALL ENSURE ALL CONSTRUCTION TRAFFIC ENTERING & LEAVING THE SITE DO SO IN A FORWARD DIRECTION.

6. MAINTENANCE AND AUDITING OF SEDIMENT AND EROSION CONTROL IN ACCORDANCE WITH THE BLUE BOOK AND ANY RELEVANT

7. LOW POINTS OF EXCAVATION SHALL BE PUMPED TO THE SEDIMENT BASIN WHERE PROVIDED.

B. PROVIDE WIND, AND DUST CONTROL IN ACCORDANCE WITH THE


9. PROVIDE BUNDS AND CATCH DRAINS AT THE TOP OF ALL BATTERS SO BATTERS ARE NOT ERODED WITH OVERLAND FLOW STORMWATER RUNOFF.

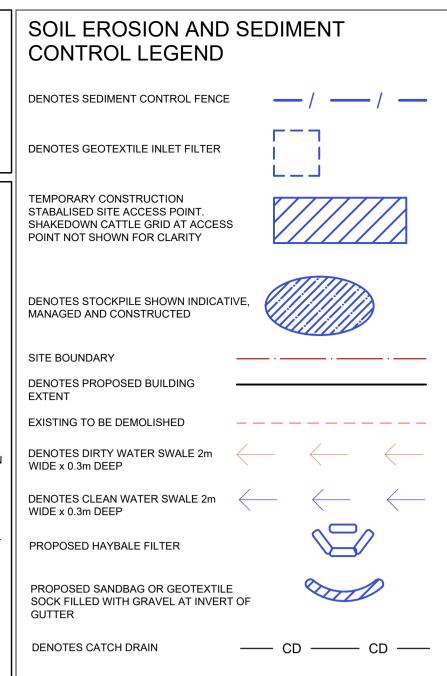

DENOTES TEMPORARY STABALISED — TM — TM — TM —

ROADBASE ROAD



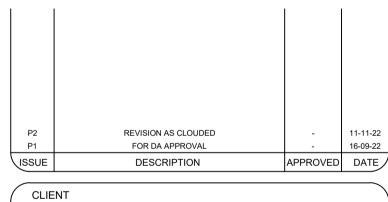








CONSULTING STRUCTURAL & CIVIL ENGINEERS 583 DARLING STREET ROZELLE NSW 2039 tel: (02) 9555 7230 email : office@birzulisassociates.com www.birzulisassociates.com

PROJECT BEDE POLDING COLLEGE,


**ALTERATIONS & ADDITIONS** 20-22 RIFLE RANGE ROAD, SOUTH WINDSOR


SOIL EROSION AND SEDIMENT CONTROL PLAN - SHEET 1A

scales as noted @ A1			DATE A	E AUG' 2021
DRAWN	DRAWN DESIGN VERIFIED			APPROVED
JM	MG	-		-
This drawing is the copyright of Birzulis Associates P/L and may not be altered, reproduced or transmitted ir form or by any means in part or in whole without the written permission of Birzulis Associates P/L td. All levels and dimensions are to be checked and verified on site prior to the commencement of any work, of shop drawings or fabrication of components. Do not scale drawings. Use figured Dimensions.				duced or transmitted in an sociates Pty Ltd. cement of any work, makir dimensions.

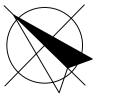


PROJECT No. P2 8252 C.DA.04A

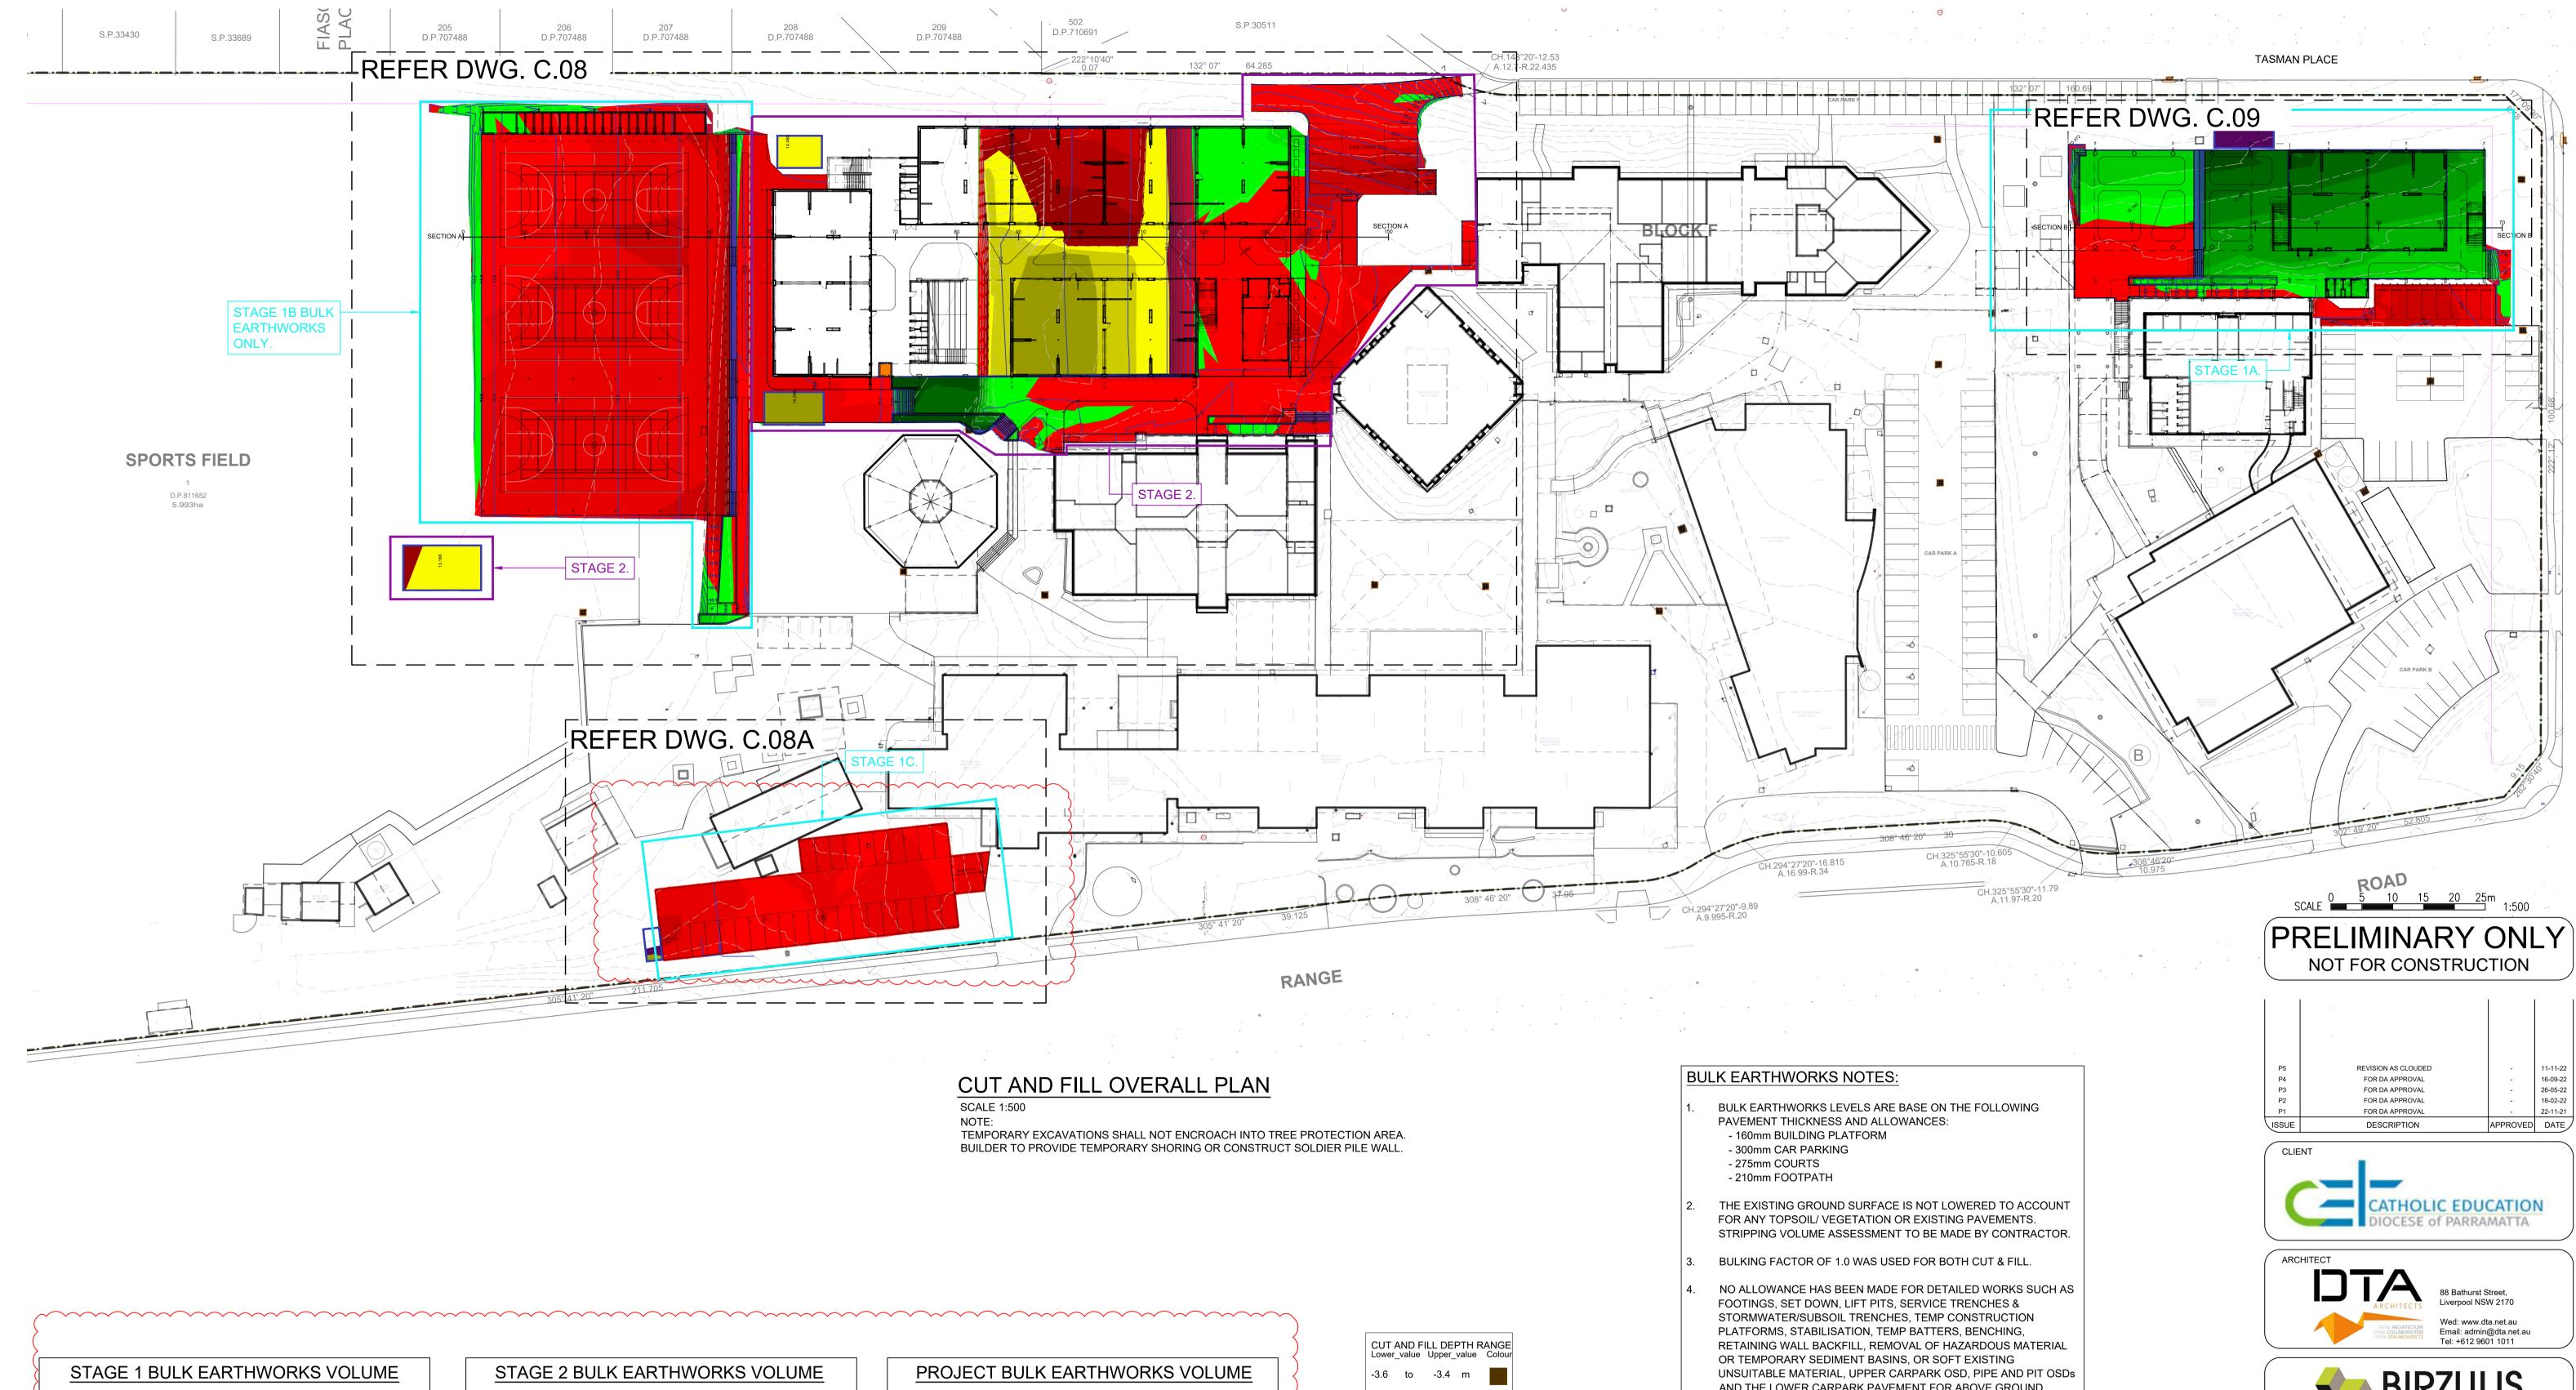

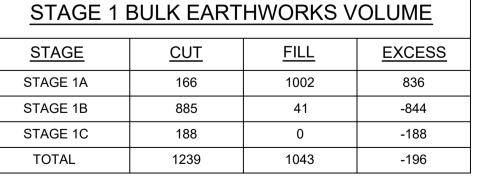

STAGE 2 BULK EARTHWORKS VOLUME					
STAGE	CUT	<u>FILL</u>	EXCESS		
STAGE 2	1957	172	-1785		
TOTAL	1957	172	-1785		

PROJECT BULK EARTHWORKS VOLUME					
STAGE	CUT	<u>FILL</u>	EXCESS		
STAGE 1	1239	1043	-196		
STAGE 2	1957	172	-1785		
TOTAL	3196	1215	-1981		

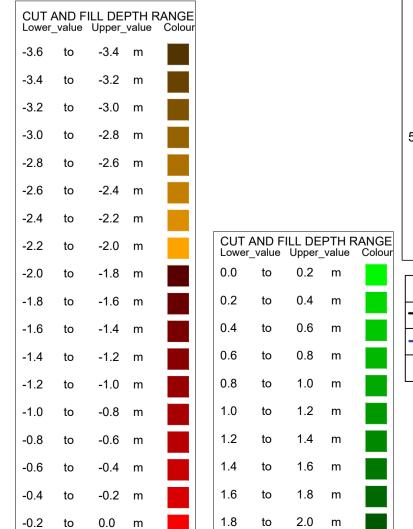

- AND THE LOWER CARPARK PAVEMENT FOR ABOVE GROUND LEVELS TO BE ACHIEVED. DETAILED SUBGRADE EXCAVATION IS REQUIRED IN VICINITY OF OSD 2.
- THIS PLAN IS PREPARED FOR INFORMATION PURPOSES ONLY AND IS INDICATIVE ONLY. EARTH WORKS CONTRACTOR IS TO VERIFY ALL LEVELS AND QUANTITIES AND PERFORM THEIR OWN BULK EARTHWORK ASSESSMENT. SOME FILL AND CUT HAS BEEN SHOWN BASED ON ASSUMED LANDSCAPE PROFILING AND IS THE RESPONSIBILITY OF OTHERS

LEGEND				
EXISTING CONTOUR				
BULK CONTOUR				
BULK CONTOUR HEIGHT				




CONSULTING STRUCTURAL & CIVIL ENGINEERS 583 DARLING STREET ROZELLE NSW 2039 tel: (02) 9555 7230 email : office@birzulisassociates.com

www.birzulisassociates.com **PROJECT** BEDE POLDING COLLEGE,

**ALTERATIONS & ADDITIONS** 20-22 RIFLE RANGE ROAD, SOUTH WINDSOR

CUT AND FILL PLAN - OVERALL

cales as noted @ A1				DATE <b>A</b>	≣ \UG' 2021	
RAWN		DESIGN	VERIFIED		APPROVED	
LD		MG	-		-	
s drawing is the copyright of Birzulis Associates P/L and may not be altered, reproduced or transmitted in any nor by any means in part or in whole without the written permission of Birzulis Associates Pty Ltd. levels and dimensions are to be checked and verified on site prior to the commencement of any work, making shop drawings or fabrication of components. Do not scale drawings. Use figured Dimensions.						
SSUE PROJECT No.		DRAWING	3 No			

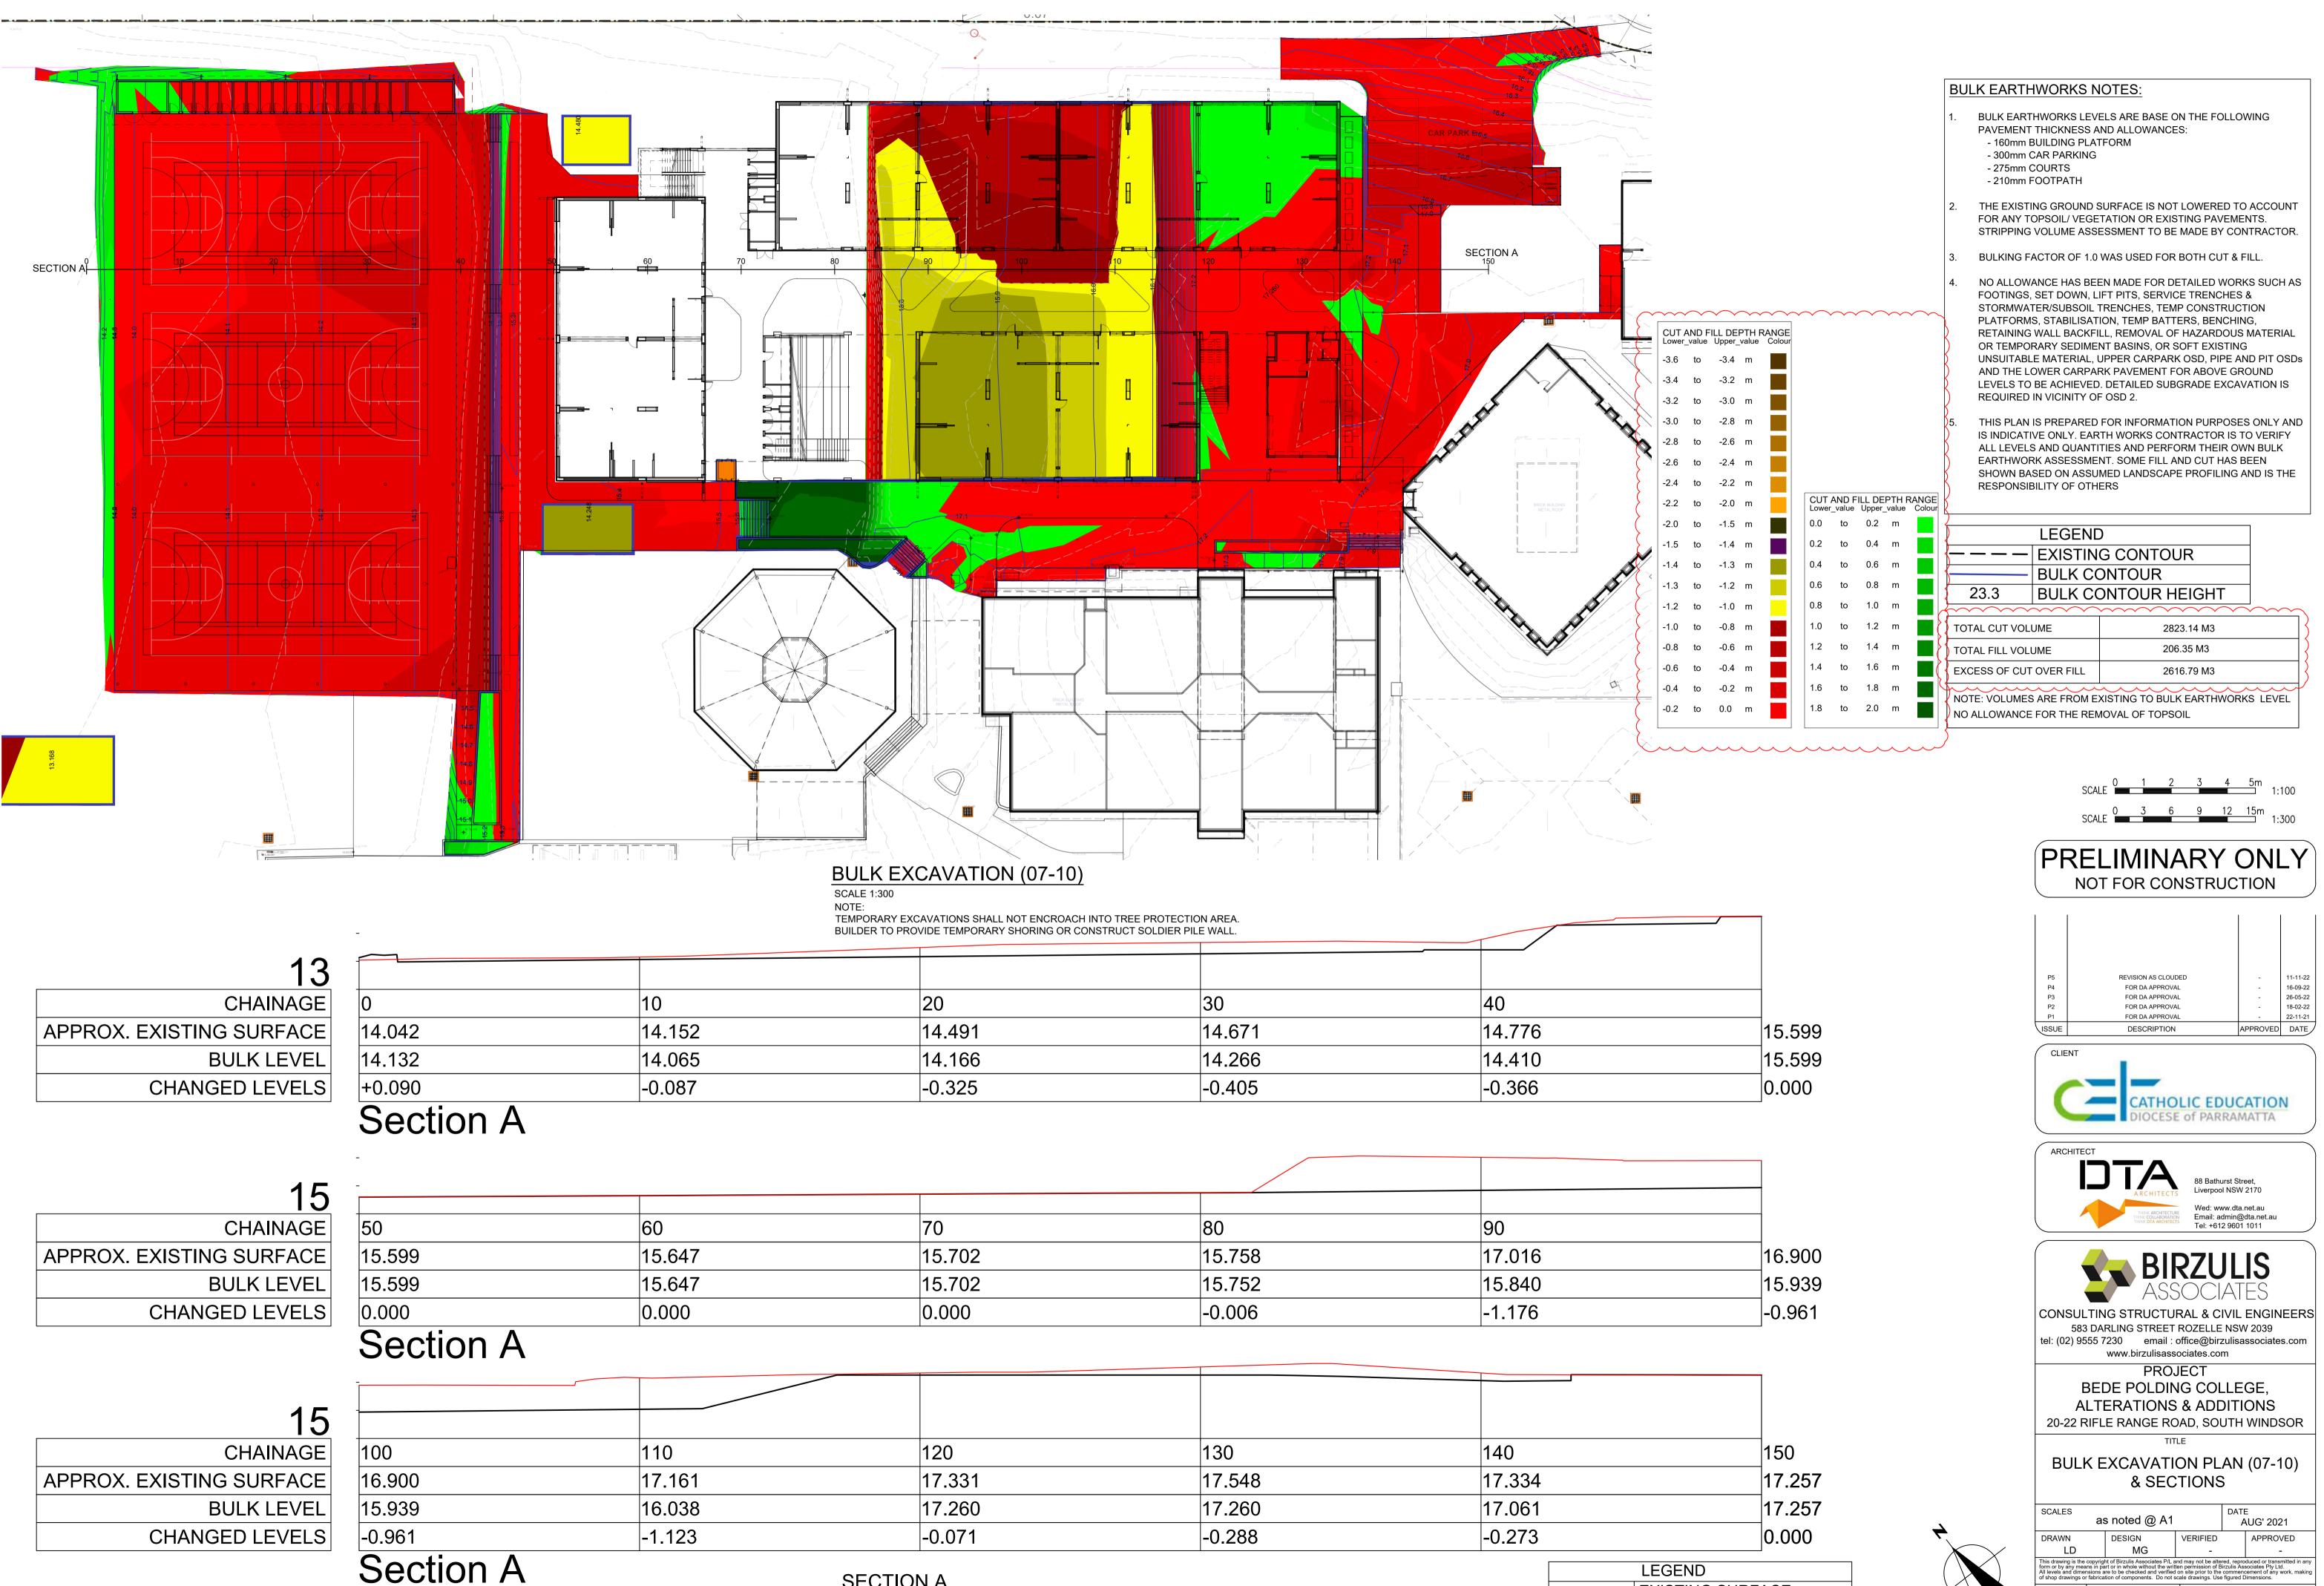

**SECTION A** 

SCALE 1:100

ISSUE

P5

PROJECT No.

8252

DRAWING No.

C.08

LEGEND

**EXISTING SURFACE** 

BULK SURFACE



### **BULK EARTHWORKS NOTES:**

CUT AND FILL DEPTH RANGE

- BULK EARTHWORKS LEVELS ARE BASE ON THE FOLLOWING PAVEMENT THICKNESS AND ALLOWANCES: - 300mm CAR PARKING
- THE EXISTING GROUND SURFACE IS NOT LOWERED TO ACCOUNT FOR ANY TOPSOIL/ VEGETATION OR EXISTING PAVEMENTS. STRIPPING VOLUME ASSESSMENT TO BE MADE BY CONTRACTOR.
- BULKING FACTOR OF 1.0 WAS USED FOR BOTH CUT & FILL.
- NO ALLOWANCE HAS BEEN MADE FOR DETAILED WORKS SUCH AS FOOTINGS, SET DOWN, LIFT PITS, SERVICE TRENCHES & STORMWATER/SUBSOIL TRENCHES, TEMP CONSTRUCTION PLATFORMS, STABILISATION, TEMP BATTERS, BENCHING, RETAINING WALL BACKFILL, REMOVAL OF HAZARDOUS MATERIAL OR TEMPORARY SEDIMENT BASINS, OR SOFT EXISTING UNSUITABLE MATERIAL, UPPER CARPARK OSD, PIPE AND PIT OSDs AND THE LOWER CARPARK PAVEMENT FOR ABOVE GROUND LEVELS TO BE ACHIEVED. DETAILED SUBGRADE EXCAVATION IS REQUIRED IN VICINITY OF OSD 2.
- THIS PLAN IS PREPARED FOR INFORMATION PURPOSES ONLY AND IS INDICATIVE ONLY. EARTH WORKS CONTRACTOR IS TO VERIFY ALL LEVELS AND QUANTITIES AND PERFORM THEIR OWN BULK EARTHWORK ASSESSMENT. SOME FILL AND CUT HAS BEEN SHOWN BASED ON ASSUMED LANDSCAPE PROFILING AND IS THE RESPONSIBILITY OF OTHERS

LEGEND		
	EXISTING CONTOUR	
	BULK CONTOUR	
23.3	BULK CONTOUR HEIGHT	

TOTAL CUT VOLUME

TOTAL FILL VOLUME	0 M3
EXCESS OF CUT OVER FILL	188 M3
NOTE: VOLUMES ARE FROM E	XISTING TO BULK EARTHWORKS LEVEL

NO ALLOWANCE FOR THE REMOVAL OF TOPSOIL


188 M3

# **BULK EXCAVATION (CARPARK)**

SCALE 1:200

TEMPORARY EXCAVATIONS SHALL NOT ENCROACH INTO TREE PROTECTION AREA. BUILDER TO PROVIDE TEMPORARY SHORING OR CONSTRUCT SOLDIER PILE WALL.



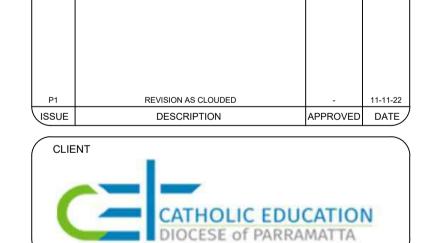





CONSULTING STRUCTURAL & CIVIL ENGINEERS 583 DARLING STREET ROZELLE NSW 2039 tel: (02) 9555 7230 email : office@birzulisassociates.com www.birzulisassociates.com

PROJECT BEDE POLDING COLLEGE,

**ALTERATIONS & ADDITIONS** 20-22 RIFLE RANGE ROAD, SOUTH WINDSOR

> **BULK EXCAVATION PLAN** (CARPARK)

as noted @ A1			DATE <b>A</b>	≣ \UG' 2021		
DRAWN	DESIGN	VERIFIED		APPROVED		
LD	MG	-		-		
This drawing is the copyright of Birzulis Associates P/L and may not be altered, reproduced or transmitted in form or by any means in part or in whole without the written permission of Birzulis Associates Pty Ltd. All levels and dimensions are to be checked and verified on site prior to the commencement of any work, ma of shop drawings or fabrication of components. Do not scale drawings. Use figured Dimensions.						


PROJECT No. 8252

DRAWING No. C.08A

LEGEND

**EXISTING SURFACE** 

BULK SURFACE

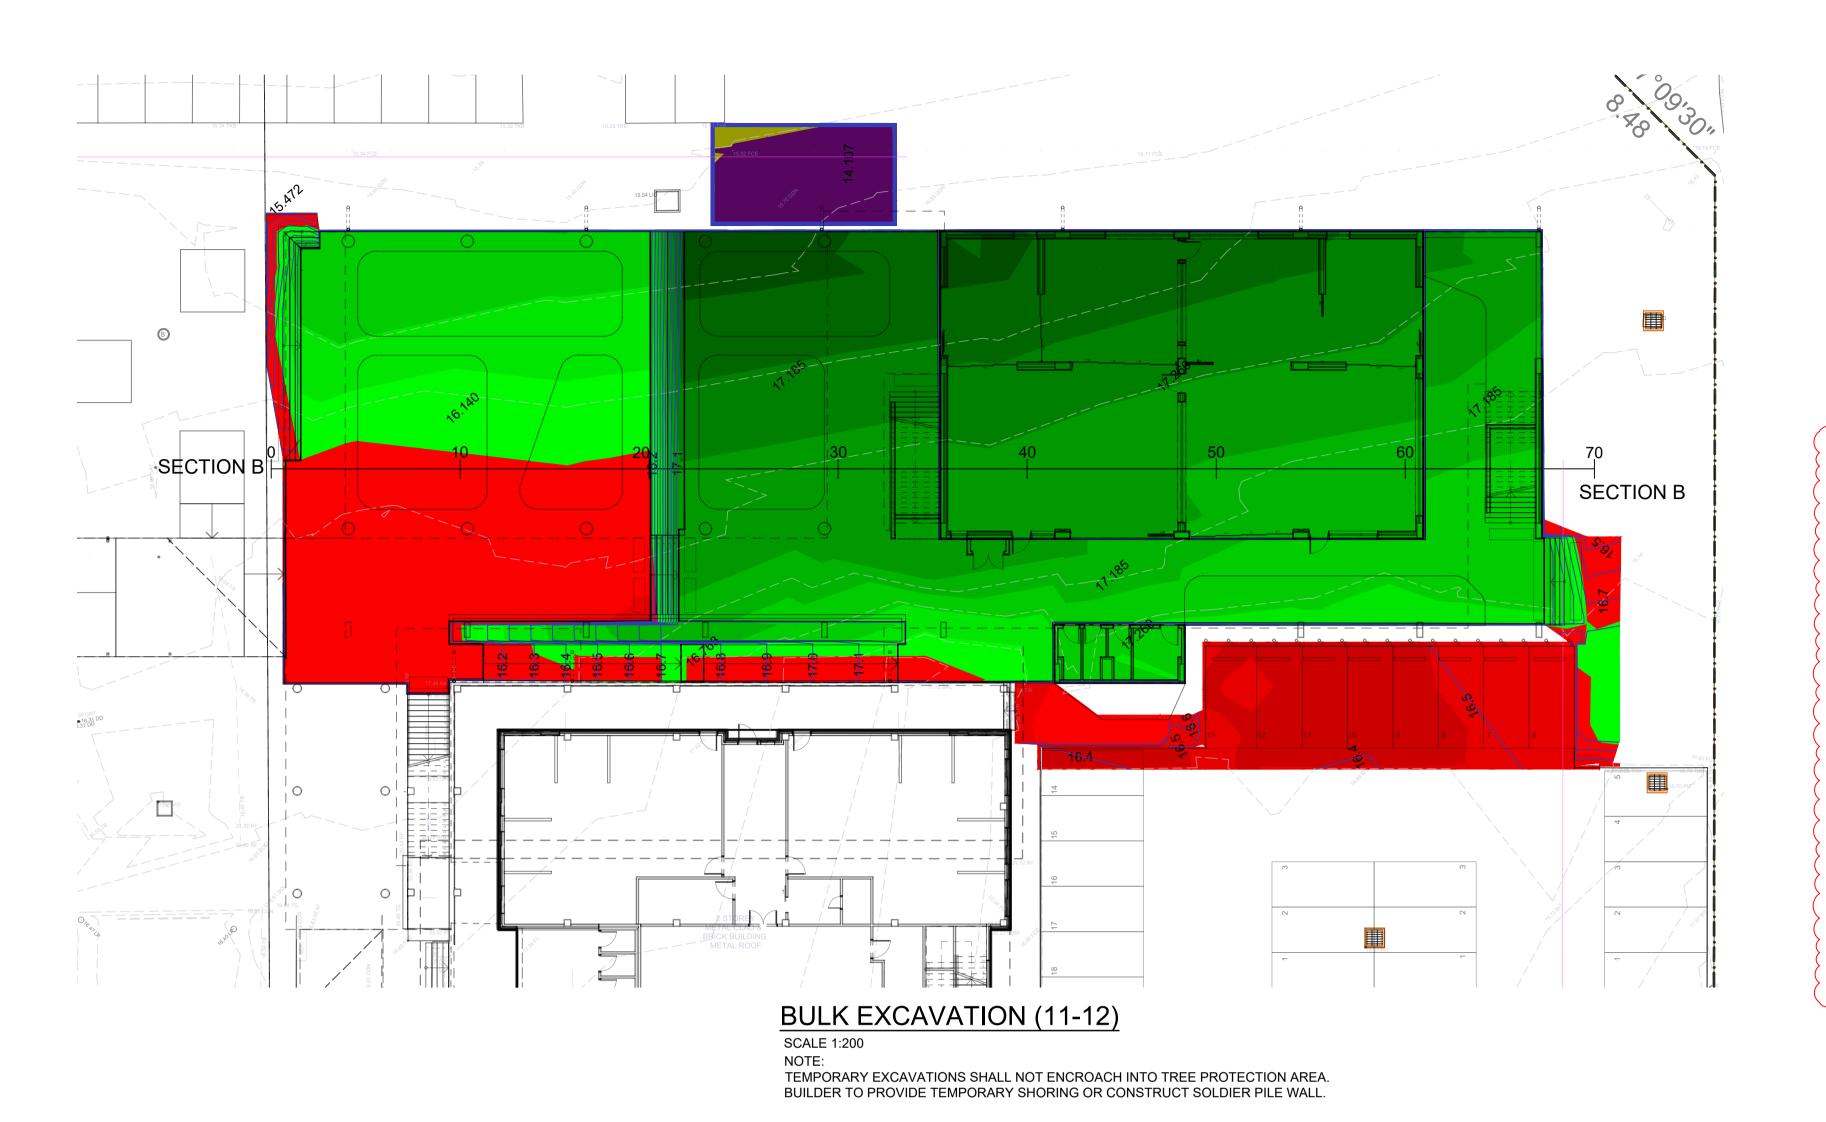

PLATFORMS, STABILISATION, TEMP BATTERS, BENCHING, CUT AND FILL DEPTH RANGE RETAINING WALL BACKFILL, REMOVAL OF HAZARDOUS MATERIAL OR TEMPORARY SEDIMENT BASINS, OR SOFT EXISTING UNSUITABLE MATERIAL, UPPER CARPARK OSD, PIPE AND PIT OSDs -3.6 to -3.4 m AND THE LOWER CARPARK PAVEMENT FOR ABOVE GROUND -3.4 to -3.2 m LEVELS TO BE ACHIEVED. DETAILED SUBGRADE EXCAVATION IS REQUIRED IN VICINITY OF OSD 2. -3.2 to -3.0 m -3.0 to -2.8 m THIS PLAN IS PREPARED FOR INFORMATION PURPOSES ONLY AND IS INDICATIVE ONLY. EARTH WORKS CONTRACTOR IS TO VERIFY -2.8 to -2.6 m ALL LEVELS AND QUANTITIES AND PERFORM THEIR OWN BULK EARTHWORK ASSESSMENT. SOME FILL AND CUT HAS BEEN -2.6 to -2.4 m SHOWN BASED ON ASSUMED LANDSCAPE PROFILING AND IS THE -2.4 to -2.2 m RESPONSIBILITY OF OTHERS CUT AND FILL DEPTH RANGE -2.2 to -2.0 m LEGEND - - - EXISTING CONTOUR 0.4 to 0.6 m **BULK CONTOUR** EXCESS ( 

**BULK EARTHWORKS NOTES:** 

- 300mm CAR PARKING - 275mm COURTS - 210mm FOOTPATH

- 160mm BUILDING PLATFORM

BULK EARTHWORKS LEVELS ARE BASE ON THE FOLLOWING

THE EXISTING GROUND SURFACE IS NOT LOWERED TO ACCOUNT FOR ANY TOPSOIL/ VEGETATION OR EXISTING PAVEMENTS. STRIPPING VOLUME ASSESSMENT TO BE MADE BY CONTRACTOR.

NO ALLOWANCE HAS BEEN MADE FOR DETAILED WORKS SUCH AS

BULKING FACTOR OF 1.0 WAS USED FOR BOTH CUT & FILL.

FOOTINGS, SET DOWN, LIFT PITS, SERVICE TRENCHES & STORMWATER/SUBSOIL TRENCHES, TEMP CONSTRUCTION

PAVEMENT THICKNESS AND ALLOWANCES:

16 CHAINAGE APPROX. EXISTING SURFACE **BULK LEVEL** CHANGED LEVELS


0	10	20	30	40
16.159	16.173	16.182	16.273	16.339
16.159	16.140	16.140	17.185	17.260
0.000	-0.033	-0.042	+0.912	+0.921
Section B	,	'	,	


16 CHAINAGE APPROX. EXISTING SURFACE **BULK LEVEL** CHANGED LEVELS

40	50	60	70
16.339	16.472	16.560	16.646
17.260	17.260	17.260	16.646
+0.921	+0.788	+0.700	0.000

# Section B


**SECTION B** SCALE 1:100

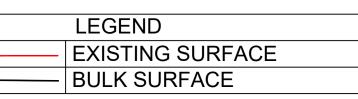


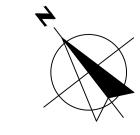

3	BULK CONTOUR HEIGHT				
~~~	~~~~		>		
UT VOLUME		166.87 M3	}		
ILL VOLUME		1002.13 M3			
OF FILL OVER CUT		835.27 M3			
OLUMES ARE FROM EXISTING TO BULK EARTHWORKS LEVEL					



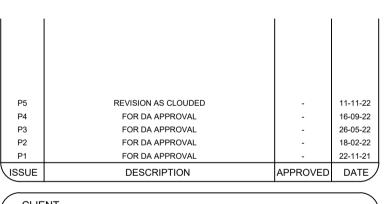

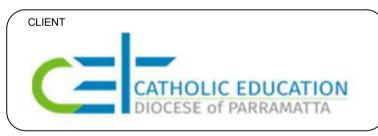





CONSULTING STRUCTURAL & CIVIL ENGINEERS 583 DARLING STREET ROZELLE NSW 2039 tel: (02) 9555 7230 email : office@birzulisassociates.com www.birzulisassociates.com

> PROJECT BEDE POLDING COLLEGE, **ALTERATIONS & ADDITIONS**


20-22 RIFLE RANGE ROAD, SOUTH WINDSOR

<b>BULK EXCAVATION PLAN (11-12)</b>
& SECTIONS

cales as noted @ A1				DATE AUG' 2021		
RAWN		DESIGN	VERIFIED		APPROVED	
LD		MG	-		-	
drawing is the copyright of Birzulis Associates P/L and may not be altered, reproduced or transmitted in an or by any means in part or in whole without the written permission of Birzulis Associates Pty Ltd. svels and dimensions are to be checked and verified on site prior to the commencement of any work, making producing or fabrication of components. Do not scale drawings. Use figured Dimensions.						
SSUE PROJECT No.		DRAWING No.				
		00-0		_		

8252


C.09

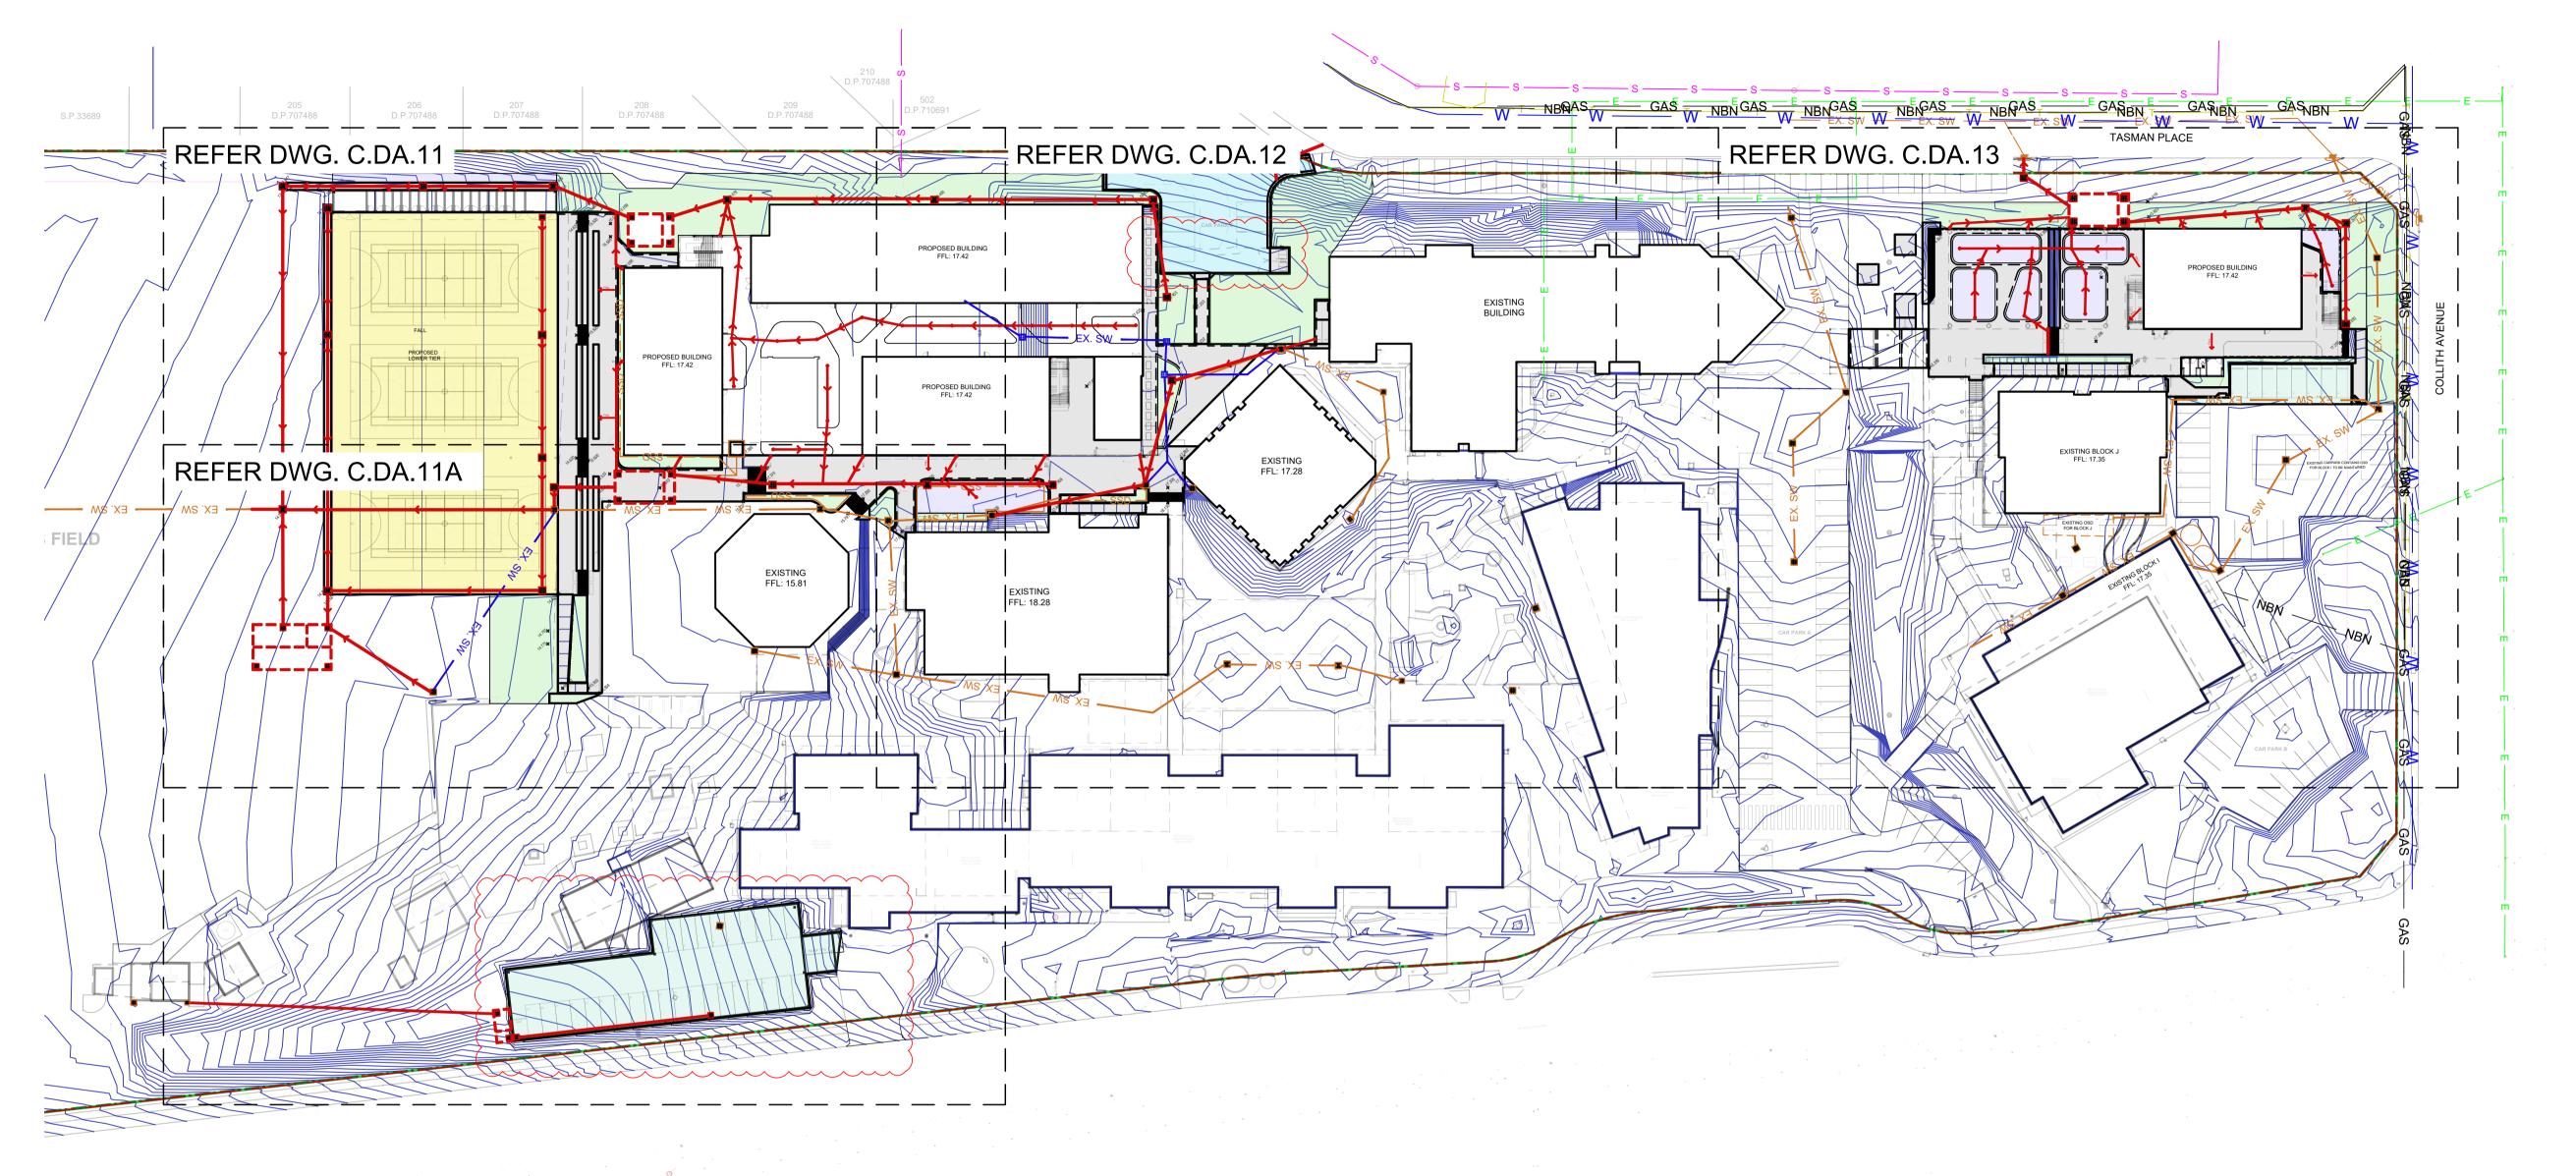


# CIVIL WORKS CONCEPT OVERALL PLAN

## SCALE 1:600

- NOTE: ROOF DRAINAGE BY OTHERS
- ALL uPVC STORMWATER DRAINAGE LINES SHALL BE 'CLASS SH' SEWER GRADE UNLESS NOTED OTHERWISE UNLESS NOTED OTHERWISE DOWNPIPES SHALL CONNECT TO THE MAIN STORMWATER LINE DOWNSTREAM
- USING 150mm DIAMETER uPVC LINES WITH MINIMUM 1% FALL.
- UNLESS NOTED OTHERWISE GRATED DRAINS SHALL BE 150x150 AND CONNECTED TO THE DOWNSTREAM (NON-CHARGED) STORMWATER SYSTEM

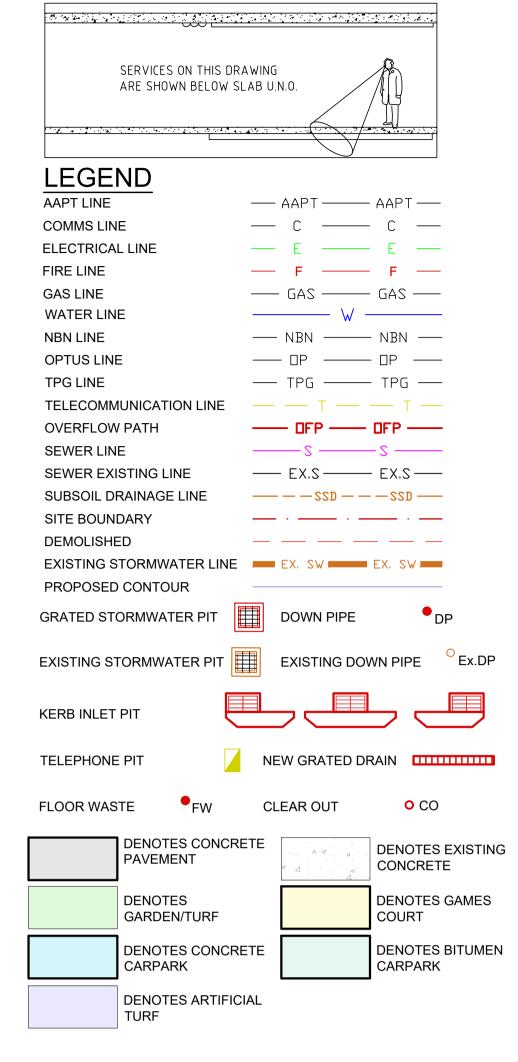



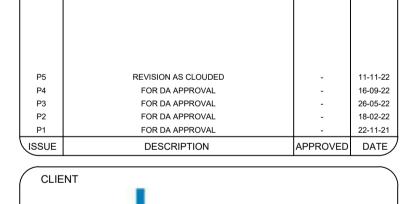





Wed: www.dta.net.au Email: admin@dta.net.au Tel: +612 9601 1011



tel: (02) 9555 7230 email : office@birzulisassociates.com www.birzulisassociates.com PROJECT


BEDE POLDING COLLEGE, **ALTERATIONS & ADDITIONS** 20-22 RIFLE RANGE ROAD, SOUTH WINDSOR


> CIVIL WORKS CONCEPT OVERALL PLAN

scales as noted @ A1				DATE AUG' 2021	
DRAWN	DESIGN	VERIFIED	-	APPROVED	
JM	MG	-		-	
This drawing is the copyright of Birzulis Associates P/L and may not be altere form or by any means in part or in whole without the written permission of Birzulia. All levels and dimensions are to be checked and verified on site prior to the or				sociates Ptv Ltd.	



of shop drawings or fabrication of components. Do not scale drawings. Use figured Dimensions. PROJECT No.

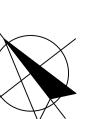


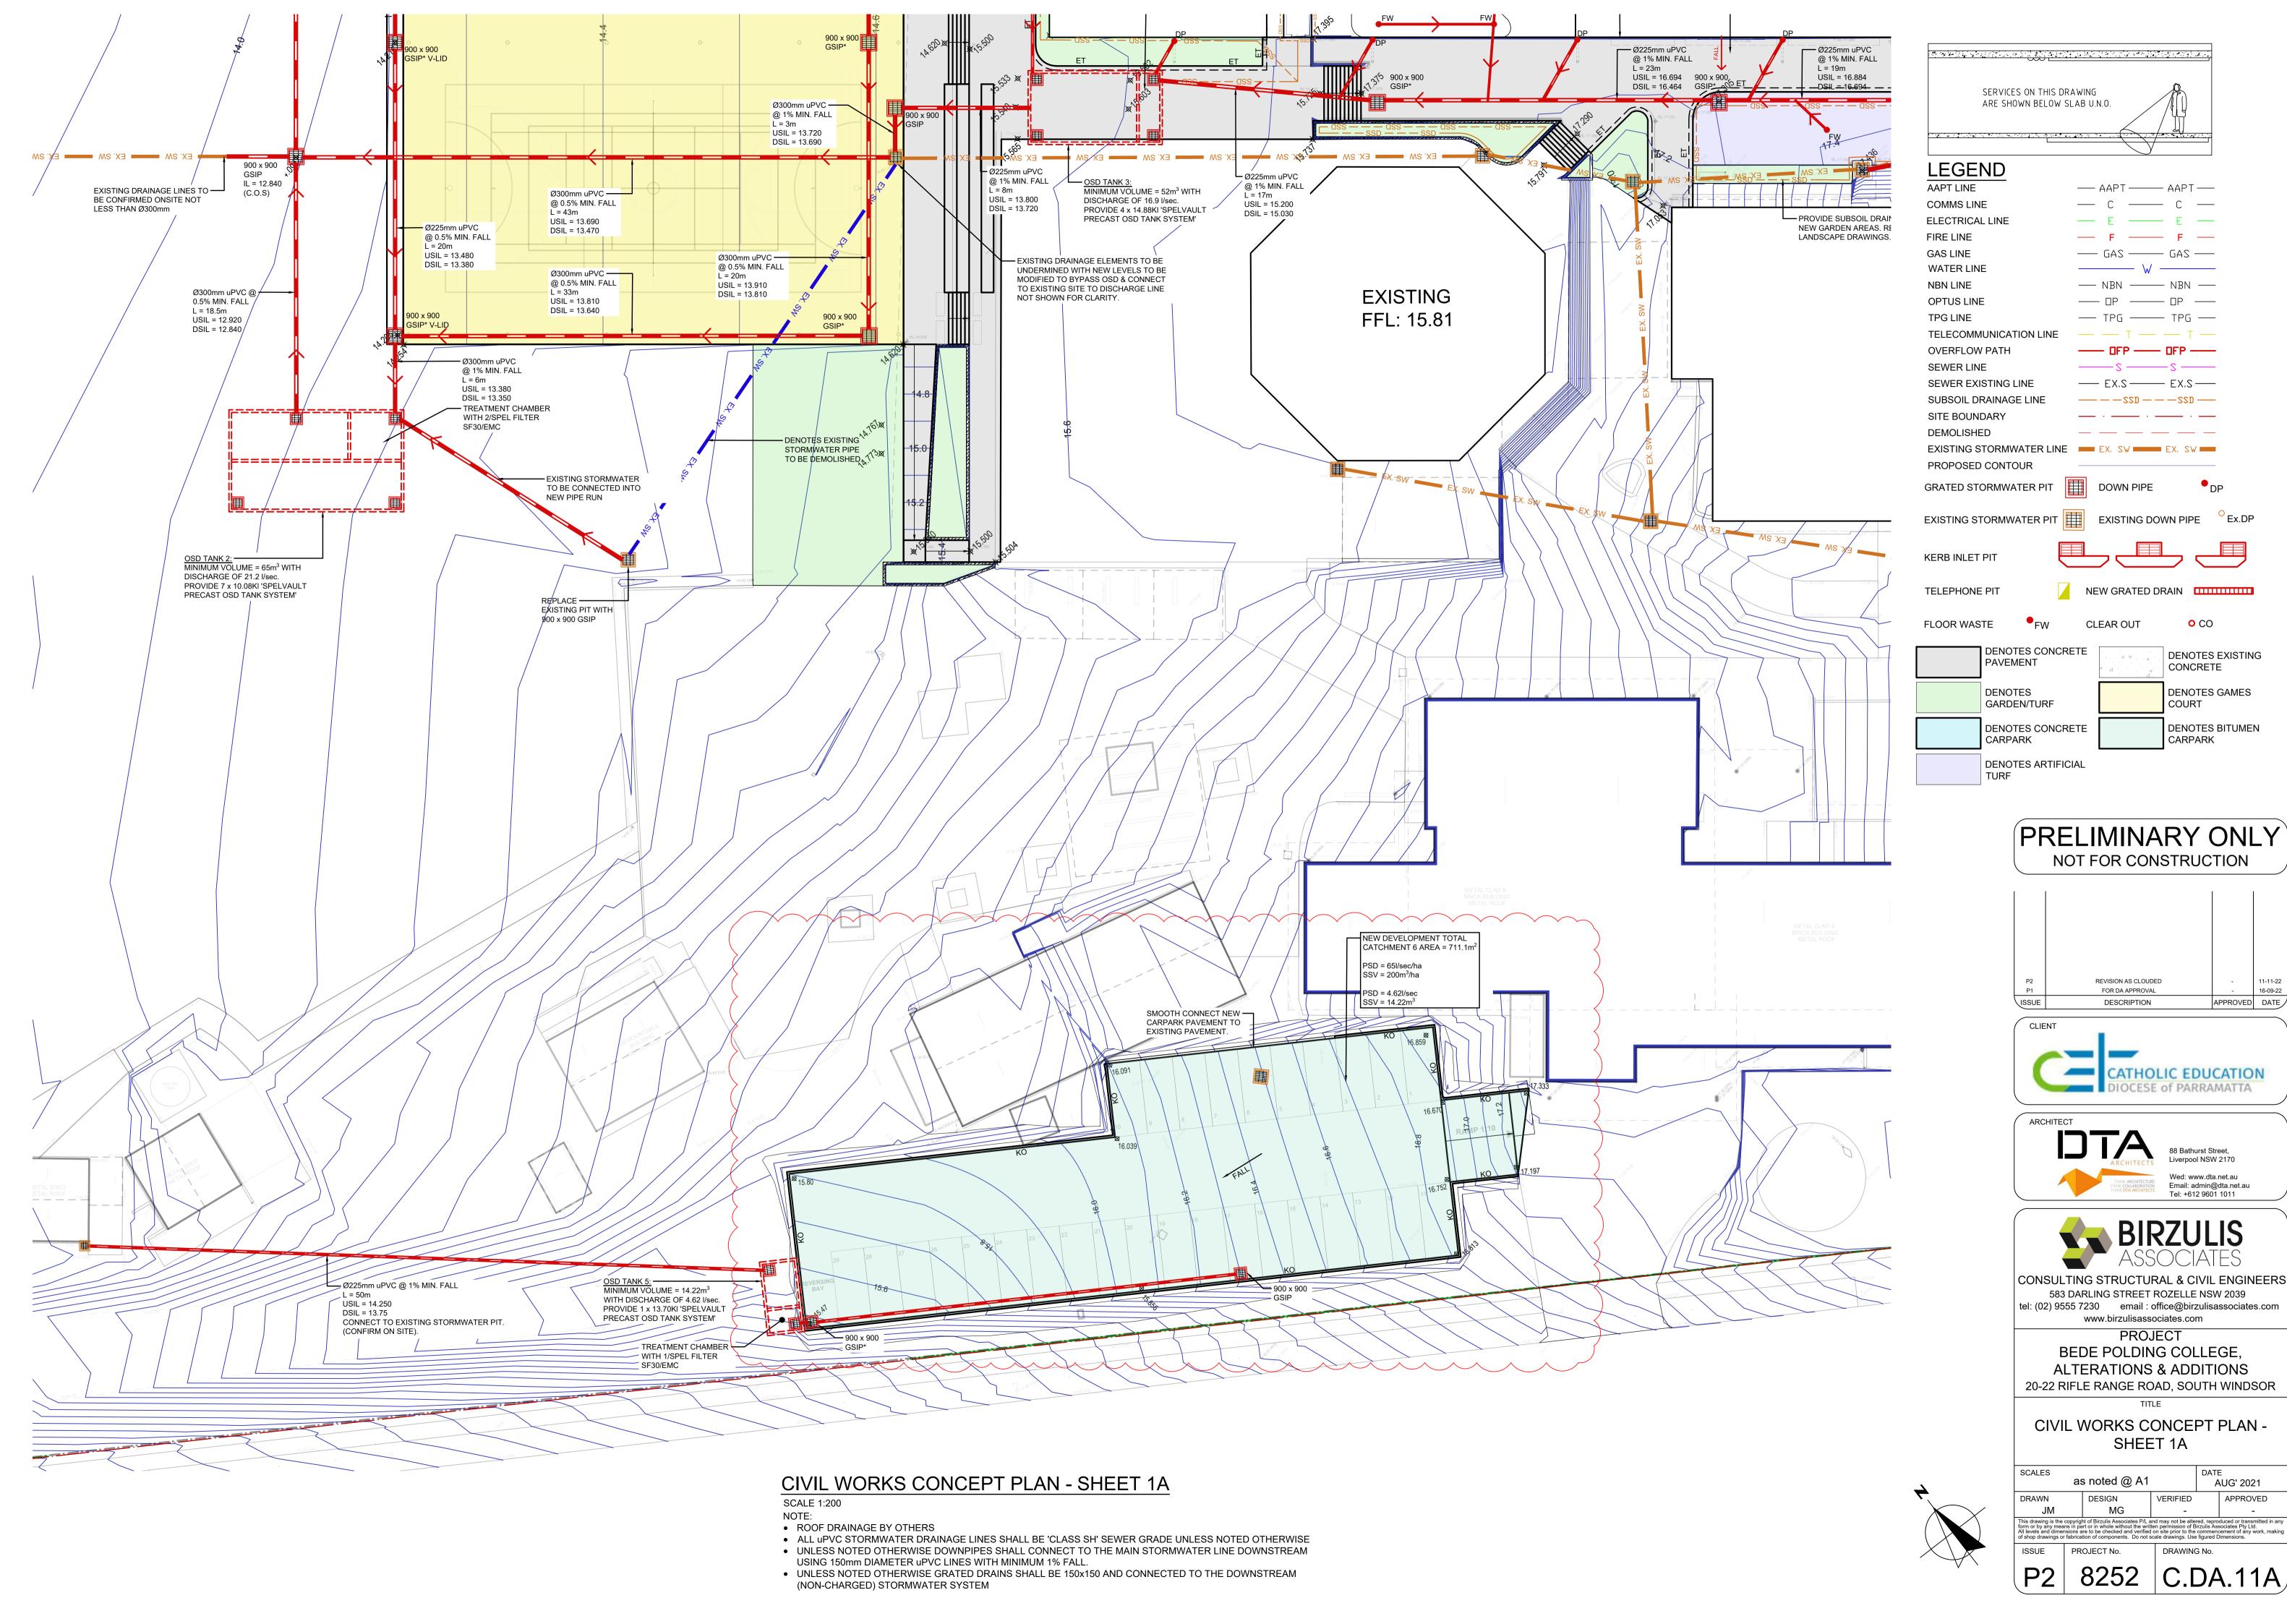


16-09-22

APPROVED DATE

AUG' 2021

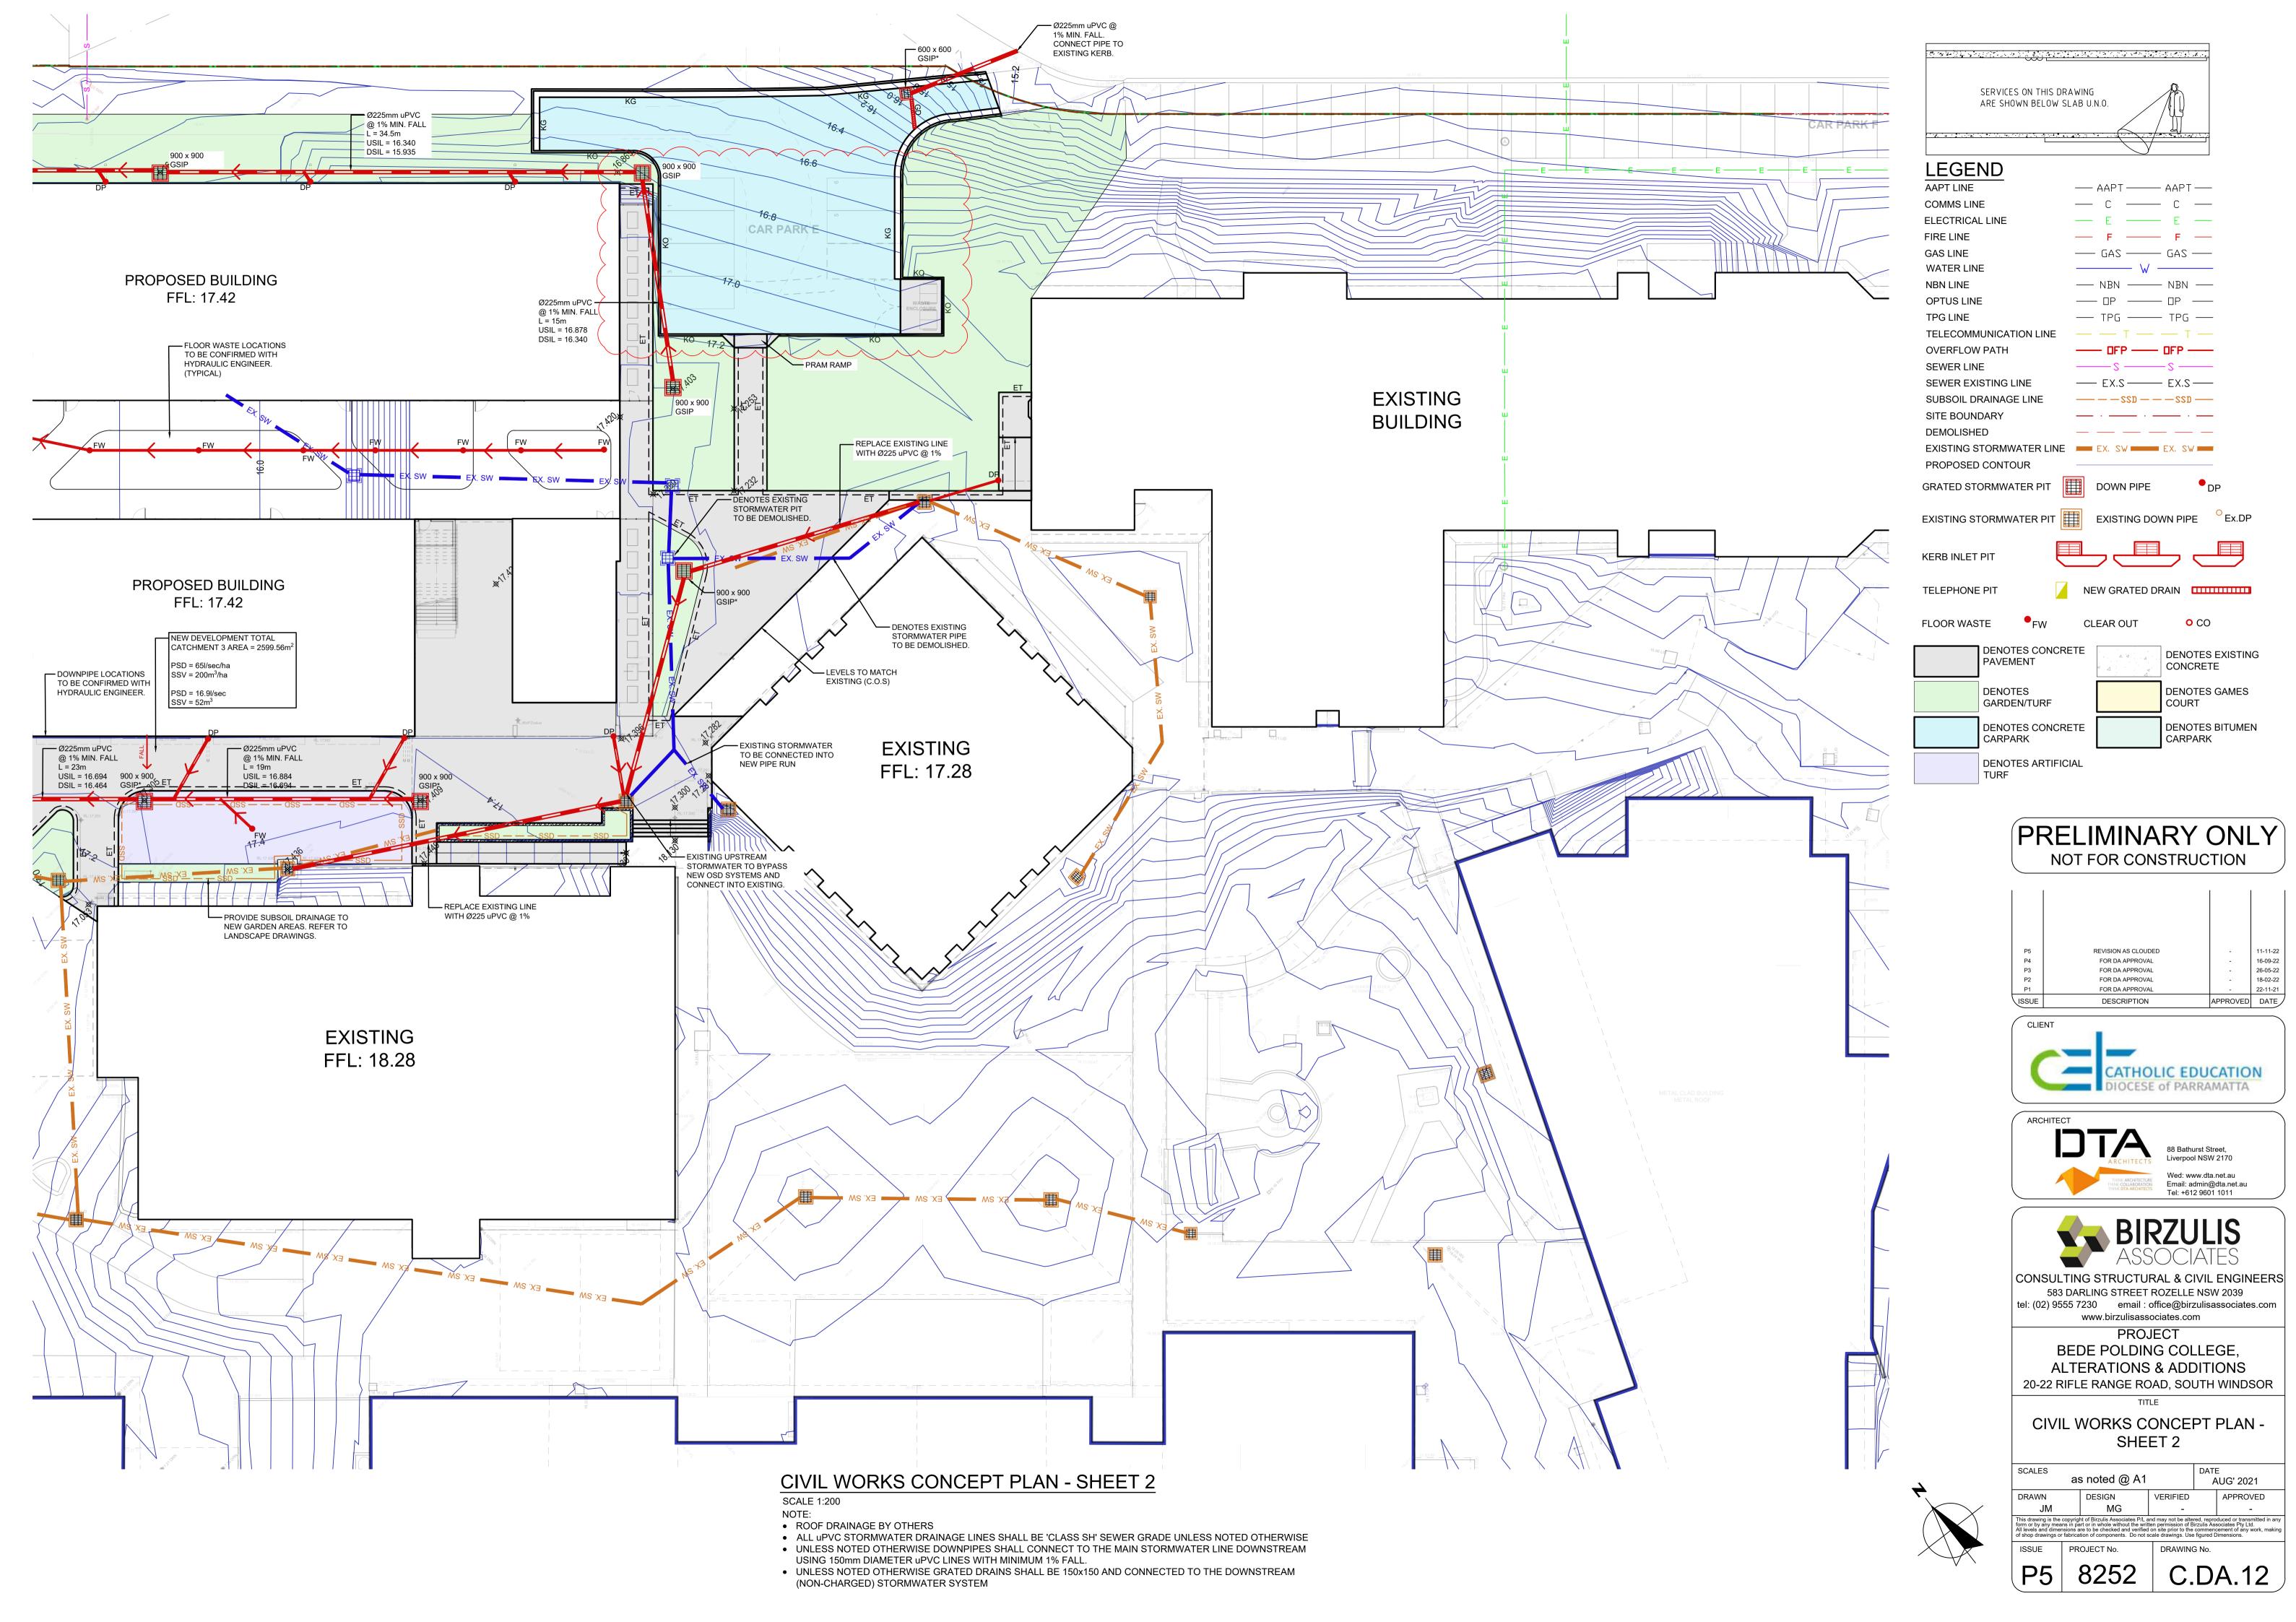

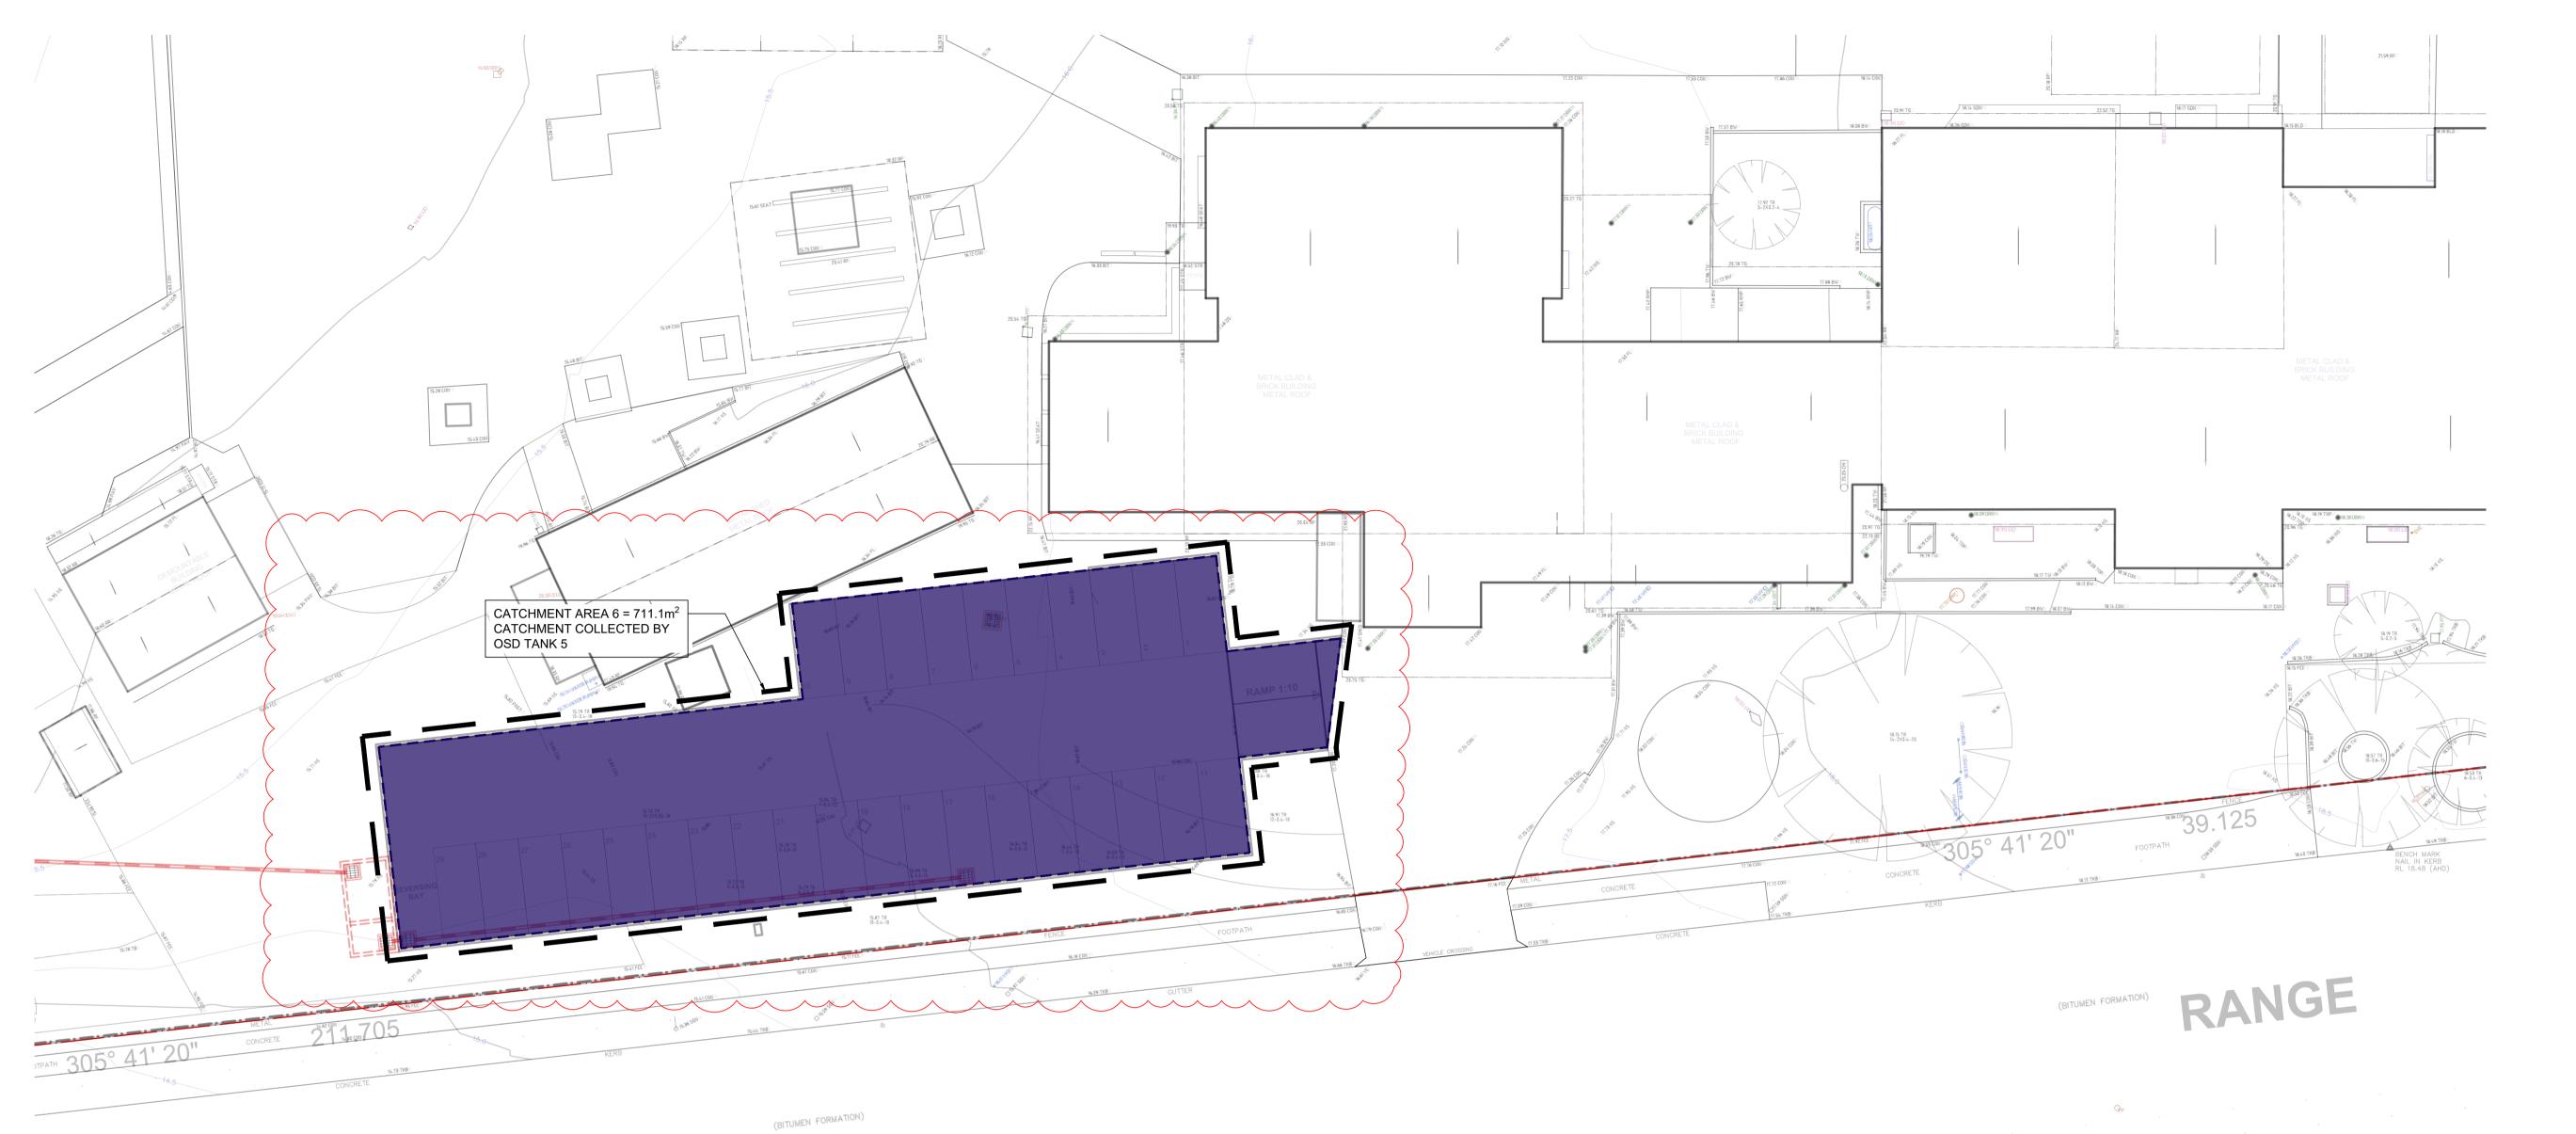

CATCHMENT PLAN - SHEET 03
SCALE 1:200

# LEGEND


ROOF CATCHMENT

PAVEMENT CATCHMENT

LANDSCAPE CATCHMENT



# PRELIMINARY ONLY NOT FOR CONSTRUCTION

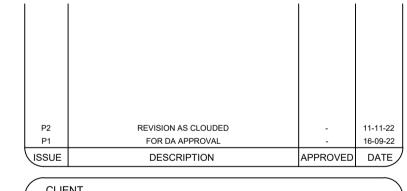







CONSULTING STRUCTURAL & CIVIL ENGINEERS
583 DARLING STREET ROZELLE NSW 2039
tel: (02) 9555 7230 email: office@birzulisassociates.com
www.birzulisassociates.com

PROJECT
BEDE POLDING COLLEGE,
ALTERATIONS & ADDITIONS
20-22 RIFLE RANGE ROAD, SOUTH WINDSOR

CATCHMENT PLAN - SHEET 03

	scales as noted @ A1				DATE AUG' 2021		
	DRAWN	DESIGN	VERIFIED		APPROVED		
	JM	MG	-		-		
This drawing is the copyright of Birzulis Associates P/L and may not be altered, reproduced or transmitt form or by any means in part or in whole without the written permission of Birzulis Associates Pty Ltd. All levels and dimensions are to be checked and verified on site prior to the commencement of any wor of shop drawings or fabrication of components. Do not scale drawings. Use figured Dimensions.							

PROJECT No. **8252** 

8252 C.E

